

APPLICATION FOR PLANNING APPROVAL

LOCAL PLANNING SCHEME No. 6 - SCHEDULE 6 - (CLAUSE. 9.1.1)

OWNERS DETAI	LS									
Name/s:	Sa	100	utore	2 0	r V	16/41		MUSCF	1	
Address:	2 Me	THE RESERVE OF THE PERSON NAMED IN	ARLI		i	St	W	ı A	Post	Code: 6415
Phone work:	/				ne hom				Fax:	
Mobile:	0438	93	2676	Ema	il:	VMUSCO	ral	bapona	t.C	on
Signature:	(M	ca					Date:	×	7.4.2020
Signature:	ture: Date: 2								2.4.2020	
	NB: T	he own	er/s signatur	e/s are	require	d for your ap	plicati	on to be process	sed.	
APPLICANTS DE	TAILS									
Name: Tomp		ering								
Address:	PO Box 6	329								
Address: Merredin WA Post Code: 641:									ost Code: 6415	
Contact person	for corresponde	ence: N	Monica T	ompk	in					
Phone work:		Phone home: Fax:								
Mobile: 0427 503 848 Email: tompkineng@merredin.net.au										
Signature: Date: 01/04/2020										
		9								
PROPERTY DETA										
Lot No:	2		House	e/Street	No:	51		Location N	lo:	
Street name:	Harling St	reet		-		mercula de la companya de la company		γ		
Suburb:	Merredin							Post Code	:	6415
Nearest street in	ntersection:	Hain	es Stree	t						
Diagram or plan: Certificate of title: Folio:					Folio:		// -/			
Title encumbrar	ices (e.g. easem	nents, re	strictive cov	enants)						1 1
		The same of the sa					~		7	
PROPOSED OR	AND REAL PROPERTY AND PERSONS ASSESSED.	ING/LA	ND USE							
Description of p development ar		Ins	stallation	of Ca	rport					
Nature of any existing buildings and/or land use: Residential - House, Patio, Shed										
	Approximate cost of proposed \$ 9.970									
	Estimated time of completion: Two months									
OFFICE USE ONL	V									
Acceptance Offi	The second secon							Date received:		
Local acuer	nt reference							Date received.		

ADJOINING PROPERTY OWNER COMMENT ON PROPOSED VARIATION TO THE RESIDENTIAL DESIGN CODES

2. ADJOINING PROPERTY DETAILS
Name: Doneen Trency
Lot No.: 50 Street No.: #21 Street Name: Haines Street
Suburb: MerredinPostcode: W.A
LOCATION OF PROPOSED DEVELOPMENT
Name: Sam & UICKI MUSCA
Lot No.: 51 Street No.: #2 Street Name: Harling Street
Suburb: Merredin Postcode: 6415
DETAILS OF VARIATION OF WHICH COUNCIL DESCRETION IS REQUIRED AND COMMENTS SOUGHT
Plan Attached
OWNER'S COMMENTS
Object/Do not object
De NOT OBJECT.
Signed: Dh Trul Date: 0/4/20 Phone: 0427 221102. Print Name: D. M. FRENCH
Print Name: D. M. FRENCH
Signed:Phone:
Print Name:

ADJOINING PROPERTY OWNER COMMENT ON PROPOSED VARIATION TO THE RESIDENTIAL DESIGN CODES

1. ADJOINING PROPERTY DETAILS
Name: Erin Kearny & Tom Gower
Lot No.: 52 Street No.: #4 Street Name: Harling Street
Suburb: Merredin Postcode: W.A
LOCATION OF PROPOSED DEVELOPMENT
Name: Salvatore & Vicki Musca
Lot No.: 51 Street No.: #2 Street Name: Harling Street
Suburb: Merredin Postcode: 6415
DETAILS OF
VARIATION OF WHICH COUNCIL DESCRETION IS REQUIRED AND COMMENTS SOUGHT
☐ Plan Attached
OWNER'S COMMENTS
Object/Do not object
Signed: Alouny Town Date: 1-4-20 Phone: 0439508 224 Print Name: Evin Keamy & Tom Gower
Print Name: Erin Keamy & Tom Gower.
Signed:Phone:
Print Name:

CODES APPROVAL APPLICATION FORM

Residential Design Codes of Western Australia

APPLICATION FOR SINGLE HOUSE/OUTBUILDING CODES VARIATION

To: Shire of Merredin
NOTE: This is not an application for Planning Approval. Application for Single House/Outbuilding Approval is to be made on this form IF an application for Planning Approval is not required under the Town Planning Scheme AND the proposed development involves one of the following: the exercise of a discretion by the Council under the Residential Design Codes; or the exercise of a discretion by the Council under a Local Planning Policy made in accordance with the Town Planning Scheme.
If you are in doubt about whether application should be made on this form, please consult the Council's planning or building officers.
OWNER DETAILS:
Name: Sam & Vicki Musca
Address: #2, Lot 51 Harling Street Merredin W.A. 6415
Signature: Date 2 4 - 2020
Signature:
All owners must sign this form or an attachment if there is not sufficient space. State your position where signing on behalf of a company. This application will not proceed otherwise.
APPLICANT DETAILS:
Name: Tompkin Engineering
Address: PO BOX 629 Mervedin, WA 6415 Contact Person: Manica Tampkin Phone: 0427 503 848
Contact Person: Manica Tampkin Phone: 0427 503 848
Fax: Email: tampkinengemerredin.net.au
Signature: Date: 7-4-20
PROPERTY DETAILS:
Lot No: 51
Location: #2 Harling Street Merredin W.A. 6415
Nearest Street Intersection: Haines Street
Title Encumbrances (e.g. easements, restrictive covenants
Approximate cost of proposed development:

DETAILS OF DISCRETIONARY DECISION(S)

- Please provide details of each aspect of the proposed development which does not conform to an "Acceptable Development" provision of the Codes or a Local Planning Policy made under the Town Planning Scheme.
- Please refer to the specific performance criterion or other provision under which the Council's discretionary decision is required and give full reasons in support of your proposal.
- 3. Attach further information in support if needed.

Clause

5.1.3 Lot boundary setback

DESCRIBE NON COMPLIANCE

1. The R-Codes define the measure of a boundary wall to include carports. This means the overall east side boundary wall exceeds the 9m max. length permitted 1.0m off the boundary. (ie. Wall will measure 17.72m including the proposed open carport). See attached site plan.

2. The proposed exceeds the Merredin Shire's planning policy table 8.22 Outbuildings in residential areas for the maximum allowable square metre of outbuildings, maximum wall & ridge heights.

For lot size 750 - 999m² Table 8.22 allows:

97m² aggregate total of all outbuildings, actual total will be 100.25m²

Maximum wall height of 3.0m, actual will be 3.05m

Maximum ridge height of 3.6m, actual will be <3.9m

Design Principle

P3.1 Buildings set back from lot boundaries so as to:

- 1. Reduce the impact of building bulk on adjoining properties
- Provide adequate direct sun and ventilation to the building and open spaces on the site and adjoining properties; and
- 3. Minimise the extent of overlooking and resultant loss of privacy on adjoining properties.

Justification

1. The R-codes do not define the structure of a carport as wall unless it's enclosed, or the floor level is greater than 0.5m above ground level. The proposed carport extension is to be open & at natural ground level. The R-Codes table 2a allows possible nil setback in accordance with clause 5.1.3. R-codes Part 5 P3.2 allows Buildings built up to boundaries (other than the street boundary).

The extension in no way adversely effects the amenity of the adjoining property, and this is made clear when comparing what is proposed and what is otherwise acceptable. In the same location, the R-Codes would otherwise permit in lieu of the 2.9m-3.05m high

(gutter height) open framed structure 1.07m off the boundary, the construction of a 3.5m high solid wall being offset 1.5m from the boundary. This wall could have a continuous eave overhang up to 750mm therefore being only 750mm off the boundary for its full length. So, the Deemed-to-Comply provisions would allow solid construction 17.7m in length at a height of 3.5m set back 1.5m from the boundary with its roof line up to 750mm off the boundary. This is taken to be the benchmark for acceptable building bulk. The proposed 2.9m-3.05m high (gutter height) carport is open therefore has very little bulk. Its only vertical building elements along the eastern boundary being three 100mm posts spaced 4.37m & 4.54m apart with the roof extending down to 2.4m above ground level. The roof line of the carport will be set back 1070mm from the boundary, this being 320 mm further than otherwise required by the Deemed-to-Comply. It is our view when compared with the benchmark set by the Deemed-to-Comply the building bulk satisfies P3.1.

2. The proposed carport extra height exceeding Merredin Shire's planning policy table 8.22 is to shelter a caravan.

OFFICE USE ONLY	
Accepting officer's initials:	.Date received
Council Reference No:	

NOTE:

THIS IS NOT A SURVEYORS PLAN. COMPONENTS DRAWN & ALIGNED AS ACCURATELY AS POSSIBLE USING MEASUREMENTS TAKEN FROM A MEASURING TAPE ONLY. ALL DIMENSIONS, LEVELS & LOCATIONS MUST BE CHECKED ON SITE PRIOR TO ANY NEW WORKS COMMENCING.

DIAL BEFORE YOU DIG - VISIT


www.1100.com.au

NOTE:

PLANS SUBJECT TO ENGINEERS CERTIFICATION

STORMWATER MANAGEMENT NOTE:

ALL GROUND LEVELS ARE TO SLOPE AWAY FROM BUILDINGS. ALL DOWNPIPES ARE TO DIRECT WATER AWAY FROM BUILDINGS BY PLUMBING TO GARDENS, LAWN AREAS, TO RAINWATER TANK/S OR SOAKWELL/S. IN DOING SO, ALL STORMWATER SHALL BE CONTAINED ON SITE & NOT ADVERSELY AFFECT NEIGHBOURING LOTS. STORMWATER KERB OUTLETS ARE SUBJECT TO APPROVAL OF THE SPECIFIC LOCAL SHIRE AUTHORITY.

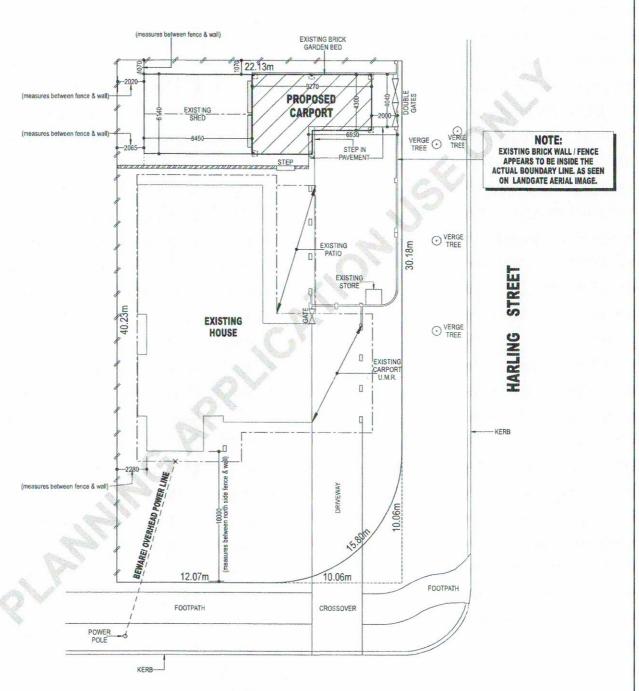


HAINES STREET



DO NOT SCALE FRO	WEBSITE: www.waynesdesignanddrafting.com.ar			
JOB TITLE : PROPOSED CARPORT AT #2.	DRAWING TITLE : s	WAYNES DESIGN		
LOT 51 HARLING STREET MERREDIN W.A. 6415 DRAWN FOR; TOMPKIN ENGINEERING	DATE: MARCH 2020	DRAWING NO.:	1	& DRAFTING DRAFTSMAN: WAYNE BILL A.B.N. 11 593 616 982
	JOB No: 19046	NO. IN SET :	5	3 ELLIS ROAD MERREDIN W.A. 6415 PH/FAX (08) 90413 937

NOTE:
PLANS SUBJECT TO
ENGINEERS CERTIFICATION


ALL DIMENSIONS, LEVELS & MATERIALS TO BE CHECKED ON SITE PRIOR TO CONSTRUCTION.

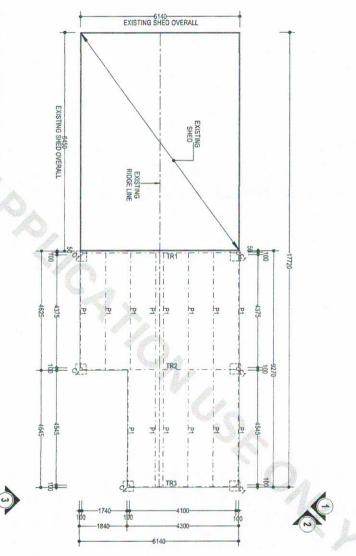



FLOOR SCALE 1:100 ROOF PLAN

CAR	CARPORT MEMBER SCHEDULE - Subject to Engineering
C	100 x 100 x 3.0mm SHS STEEL COLUMN (GALVANISED)
TR1	100 x 50 x 1.6mm RHS STEEL FULLY WELDED TRUSS (GALVANISED)
TR2	100 x 50 x 1.6mm RHS STEEL FULLY WELDED TRUSS (GALVANISED
TR3	100 x 50 x 1.6mm RHS STEEL FULLY WELDED TRUSS (GALVANISED)
P	100 x 50 x 2.0mm RHS STEEL PURLIN (GALVANISED)
81	100 x 50 x 2.0mm RHS BEAM BETWEEN COLUMNS (GALVANISED)

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3 ELLIS ROAD MERREDIN W.A. 6415 PH/FAX (08) 90413 937	NO. IN SET: 5	JOB No: 19046	TOMPKIN ENGINEERING
A.B.N. 11 593 616 982			DRAWN FOR:
DRAFTSMAN: WAYNE BILL	DRAWING NO.: 2	DATE: MARCH 2020	
& DB AFTING			PROPOSED CARPORT AT #2,
WAYNES DESIGN	FLOOR / ROOF PLAN	DRAWING TITLE:	JOB TITLE :
WEBSITE: www.waynesdesignanddrafting.com.au	USIONS SHOWN ONLY.	DO NOT SCALE FROM DRAWINGS. USE DIMENSIONS SHOWN ONLY	DO NOT SCALE FROM

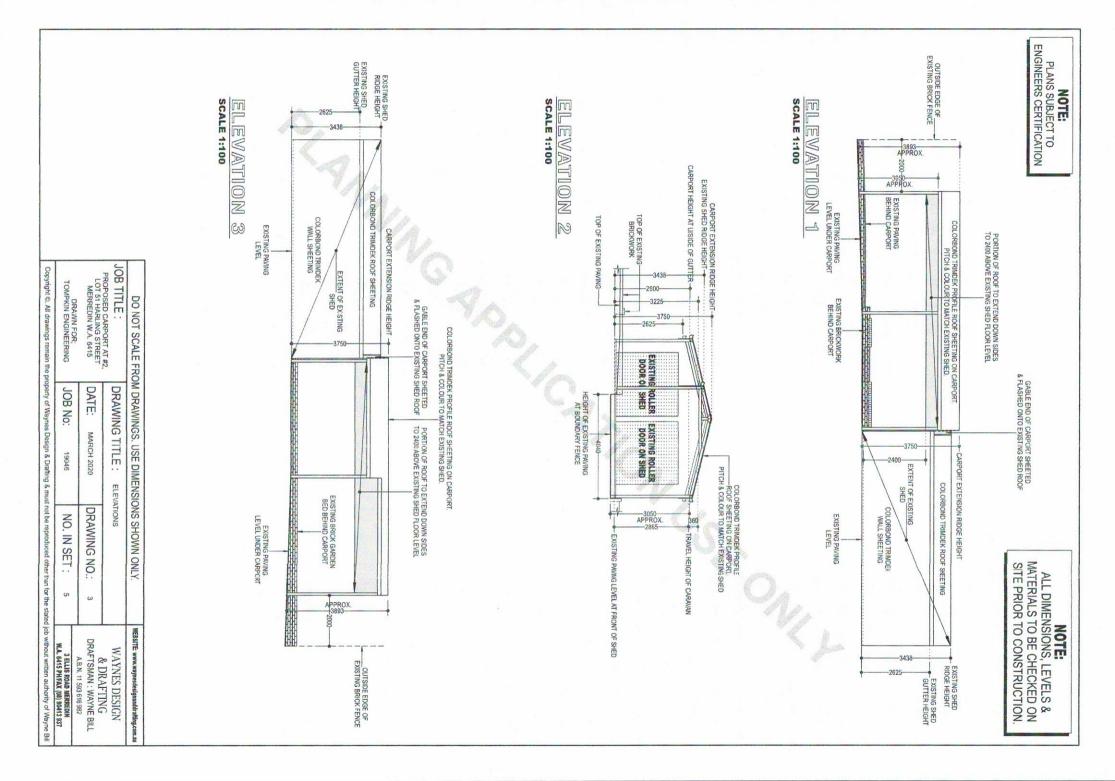

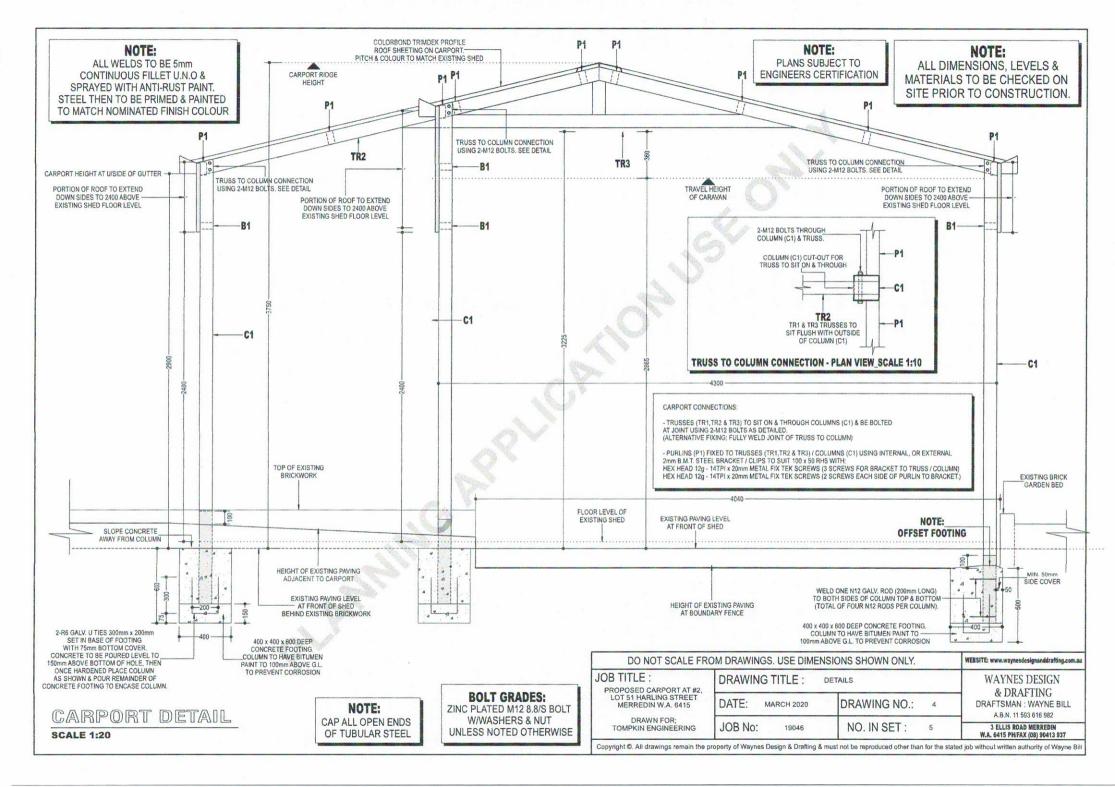

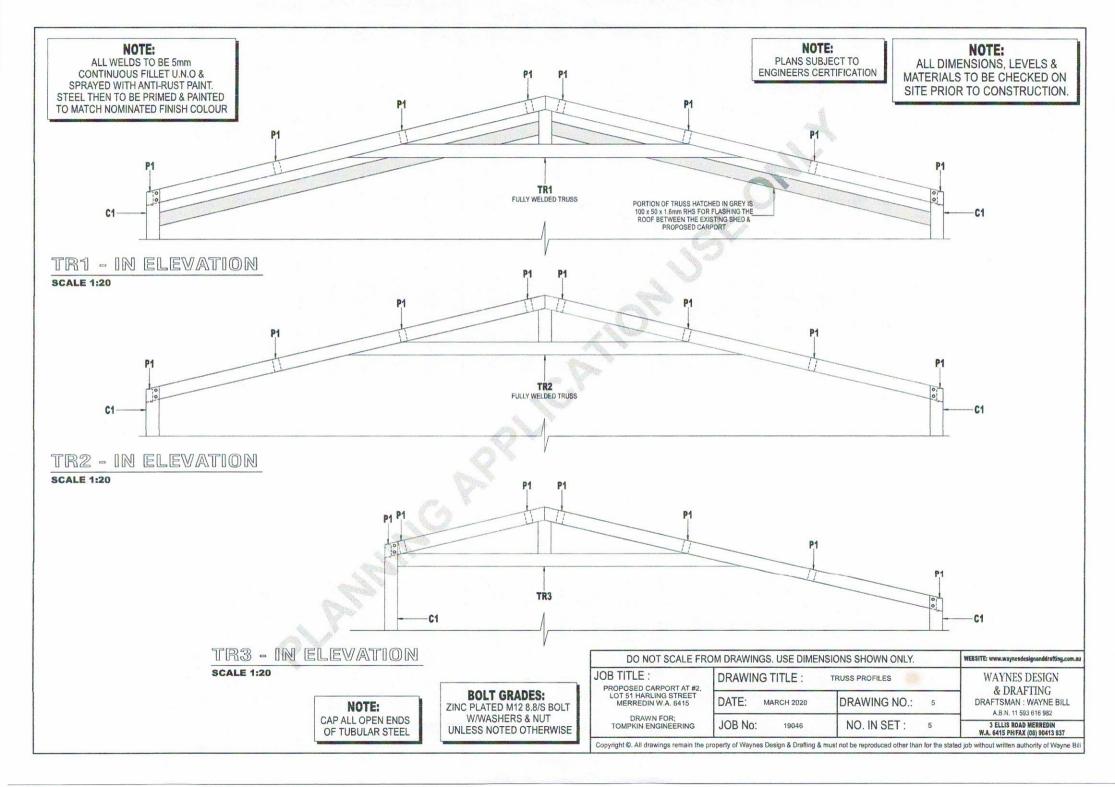

POLICY NUMBER

-. 8.22

POLICY SUBJECT

8.22 Outbuildings in Residential Areas

ADOPTED

- 19 August 2003 (CMRef 27163)

AMENDED

- 17 July 2012 (CMRef 30919)

AMENDED

20 December 2016

Objectives:

To ensure a level of consistency with the size, the height and setbacks of outbuildings in residential areas, to minimise any adverse impact on the amenity to neighbouring property owners and to contribute towards the aesthetics of the streetscape.

Definitions:

Residential Areas:

Any Residential, Special Residential and Rural Residential zones.

Outbuilding:

Any Class 10a building under the current National Construction Code (BCA) which is not connected or abutted to a dwelling.

Reflective Materials:

Not limited to, but includes the following:

- Zincalume® or similar product;
- Any shiny metallic finish; and
- White coloured metallic

materials.

Maximum single outbuilding m²:

The maximum floor area of any single outbuilding measured from the external edges of the wall cladding or in the case of an unenclosed building where the external edges of the wall cladding would be if the structure was enclosed.

Aggregate total of all outbuildings m²:

The total floor area of all outbuildings located on the site and measured from the external edges of the wall cladding or in the case of an unenclosed building where the external edges of the wall cladding would be if the structure was enclosed.

Policy:

Outbuildings that satisfy the following development criteria may be approved by the Executive Manager of Development Services.

- a) Outbuildings which are enclosed are to be located behind the primary street setback in accordance with the Shire of Merredin Local Planning Scheme No 6 (as amended) and the State Planning Policy 3.1 Residential Design Codes;
- b) All enclosed outbuildings to have a minimum setback of 1500mm from any secondary street, right of way or private street frontage;
- c) Supports to an open carport, may be placed up to a boundary, other than a primary street, secondary street, right of way or private street provided they are of non-combustible material and the roof-line of the carport is setback a minimum of 500mm from that boundary in accordance with the National Construction Codes (BCA).
- d) Outbuildings comply with the current National Construction Code (BCA).
- e) An application that indicates that reflective materials are to be used for wall and or roof cladding and in the opinion of the Executive Manager of Development Services, is likely to cause a nuisance to neighbouring property owners may be refused.
- f) If in the opinion of the Executive Manager of Development Services, an application that indicates the use of reflective materials for wall and or roof cladding is likely to cause a nuisance to neighbouring property owners,
 - May be refused; or
 - The applicant may wish to provide clear and fully detailed documentation to show how any reflective issues will be addressed so as not to cause a nuisance to neighbouring property owners; or
 - In the opinion of the Executive Manager of Development Services, any reflective issues that may arise and to cause a nuisance to neighbouring property owners is likely to be minimal, the property owner/s may enter into an

agreement with Council, at the Chief Executive Officers discretion and at the property owner's expense, that should there be a valid complaint, that the owner/s will immediately do such things to minimize the nuisance, by, but not limited to painting or screening with Council's prior approval.

- g) Outbuildings are constructed of all new materials; or
- h) Where pre used materials are proposed to be used,
 - The applicant will be required to provide sufficient detail, specifications and photos to demonstrate to the Executive Manager of Development Services that the appearance of the proposed pre used materials will not detract from the streetscape; or
 - The applicant may need to provide detail of how they intend to treat the used materials so that the finish will meet an acceptable standard; and
 - The applicant may be required to provide Certification from a Practising Structural Engineer as to the structural adequacy of the design and or materials proposed to be used.
- i) Out buildings are not for habitable or commercial purposes;
- j) The construction of an outbuilding does not reduce the amount of open space required by the Residential Design Codes to less than the prescribed amount;
- k) Outbuildings are of size in area, or the aggregate total of size in area of all the outbuildings on the lot and the wall and ridge heights comply with the values contained in Policy Table 8.22 Outbuildings in Residential Areas.
- I) For minor variations the Executive Manager of Development Services may consider Code Variations in accordance with the Residential Design Codes of Western Australia (RDC) and view such applications on the proposed project's merits as detailed within the RDC.

Policy Table 8.22 Outbuildings in Residential Areas

LOT AREA (m²)	MAXIMUM SINGLE OUTBUILDING (m²)	AGGREGATE TOTAL OF ALL OUTBUILDINGS (m²)	MAXIMUM WALL HEIGHT	MAXIMUM RIDGE HEIGHT
500 – 749	46	62	2.4	3.6
750 – 999	73	97	3.0	3.6
1000 – 1249	94	125	3.0	3.6
1250 – 1699	117	156	3.0	3.9
1700 – 2049	130	202	3.0	3.9
2050 – 2999	143	262	3.3	4.2
3000 – 5000	157	375	3.6	4.5